



CUSTOM HOMES
REMODELS
ADDITIONS
253.282.2277

PAVEL2TRAVEL@GMAIL.COM

SCALE:

1/4" = 1'-0"

ENGINEERING:

BLDG DEPT:

MERCERISLAND

CHECKED BY:

PRINT DATE:

12.920

REVISIONS

12.920 PRELIMINARY PVS

BUILDER APPROVAL:

DATE

OWNER APPROVAL:

DATE

DATE

PLAN NUMBER


PROJECT


PREMIUM HOMES
OF MERCER ISL
REMODEL

2906 74th Ave SE Mercer Island W A S H I N G T O N 9 8 0 4 0

531510-0836 SHEET TITLE:

SHEET NUMBER:

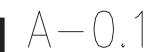

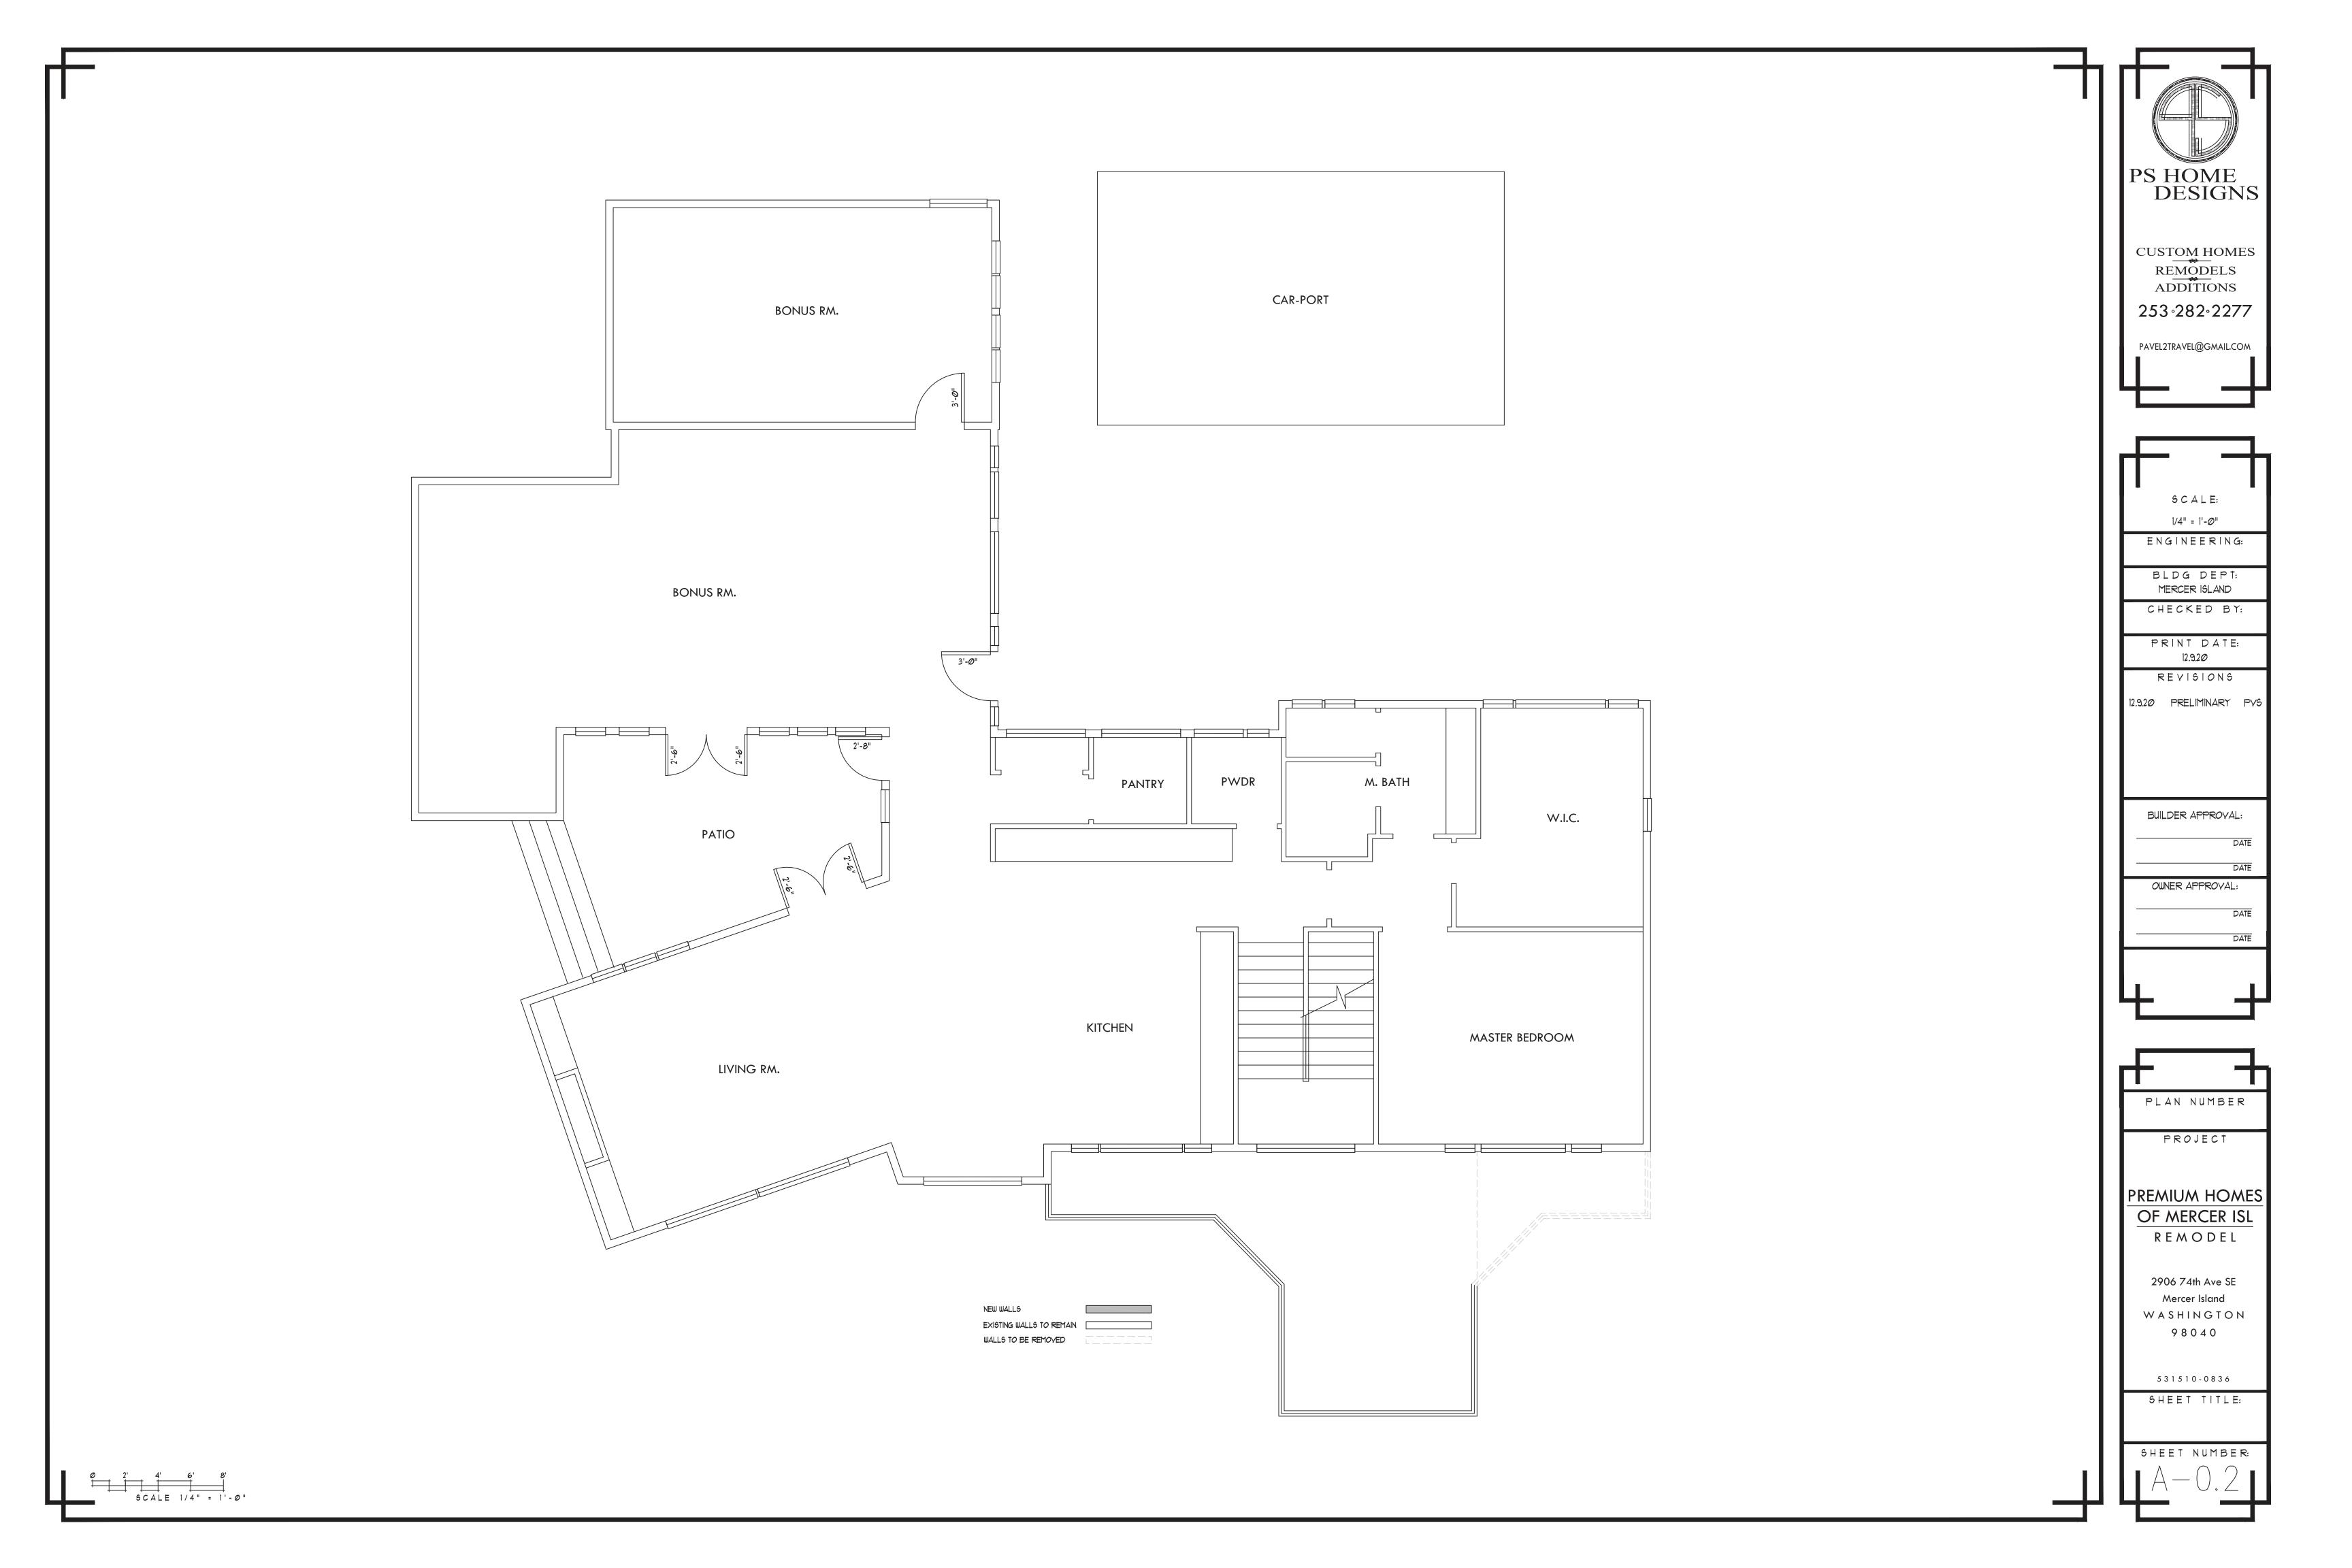

#### INSULATION BAFFLE NOTE:

WHEN EAVE VENTS ARE INSTALLED, BAFFLING OF THE VENT OPENINGS SHALL BE PROVIDED SO AS TO DEFLECT THE INCOMING AIR ABOVE THE SURFACE OF THE INSULATION. BAFFLES SHALL BE RIGID MATERIAL, RESISTANT TO WIND DRIVEN MOISTURE. BAFFLES SHALL BE INSTALLED FROM THE TOP OF THE OUTSIDE OF THE EXTERIOR WALL, EXTENDING INWARD, TO A POINT 6" VERTICALLY ABOVE THE HEIGHT OF NON COMPRESSED INSULATION, AND 12" VERTICALLY ABOVE LOOSE FILL INSULATION

OPEN-BLOWN OR POURED LOOSE FILL INSULATION MAY BE USED IN ATTIC SPACES WHERE THE SLOPE OF THE CEILING IS NOT MORE THAN 3 FEET IN 12 AND THERE IS AT LEAST 30" OF CLEAR DISTANCE FROM THE TOP OF THE BOTTOM CHORD OF THE TRUSS OR CEILING, JOIST TO THE UNDERSIDE OF THE SHEATHING, AT THE ROOF RIDGE.

#### FIREBLOCKING NOTE:

PROVIDE 2"X FIREBLOCKING
AT ALL CONCEALED SPACES OF STUD WALLS
WAND PARTITIONS INCLUDING FURRED SPACES,
AT THE CEILING AND FLOOR LEVELS AND AT 10'-0"
INTERVALS BOTH VERTICAL AND HORIZONTAL

#### SHOWER NOTES

ALL SHOWER RECEPTORS SHALL BE TESTED
FOR WATERTIGHTNESS BY FILLING WITH WATER TO THE
LEVEL OF THE ROUGH THRESHOLD. THE TEST PLUG
SHALL BE SO PLACED THAT BOTH UPPER AND UNDER
SIDES OF THE SUB-PAN SHALL BE SUBJECTED TO THE
TEST AT THE POINT WHERE IT IS CLAMPED TO THE DRAIN

WHEN GYPSUM IS USED AS A BASE FOR TILE WALL PANELS FOR TUB, SHOWER, OR WATER CLOSET COMPARTMENT WALLS WATER RESISTANT GYPSUM BACKING BOARD SHALL BE USED. WATER RESISTANT GYPSUM BOARD SHALL NOT BE USED IN THE FOLLOWING AREAS


OVER A VAPOR RETARDER
IN AREAS SUBJECT TO CONTINUOUS HIGH HUMIDITY SUCH
AS SAUNAS, STEAM ROOMS, OR GANG SHOWER ROOMS.
ON CEILINGS WHERE FRAME SPACING EXCEEDS 12" O.C.

# EGRESS NOTES

ALL WINDOWS LABELED AS EGRESS
ON PLAN MUST MEET THE MINUMUM
REQUIREMENTS FOR EGRESS WINDOWS

EGRESS WINDOWS SHALL HAVE A
MINIMUM NET CLEAR OPENING AREA OF
5.7 SQFT. THE MINIMUM NET CLEAR
OPENING HEIGHT SHALL BE 24" THE
MINIMUM NET CLEAR OPENING WIDTH
SHALL BE 20" HEIGHT TIMES THE WIDTH
SHALL NOT BE LESS THAN 5.7 SQFT.

ALL WINDOWS LABELED AS EGRESS ON PLAN SHALL HAVE AN OPENING HEIGHT OF NOT MORE THAN 44" ABOVE FINISHED FLOOR LEVELS PER IRC 310.1

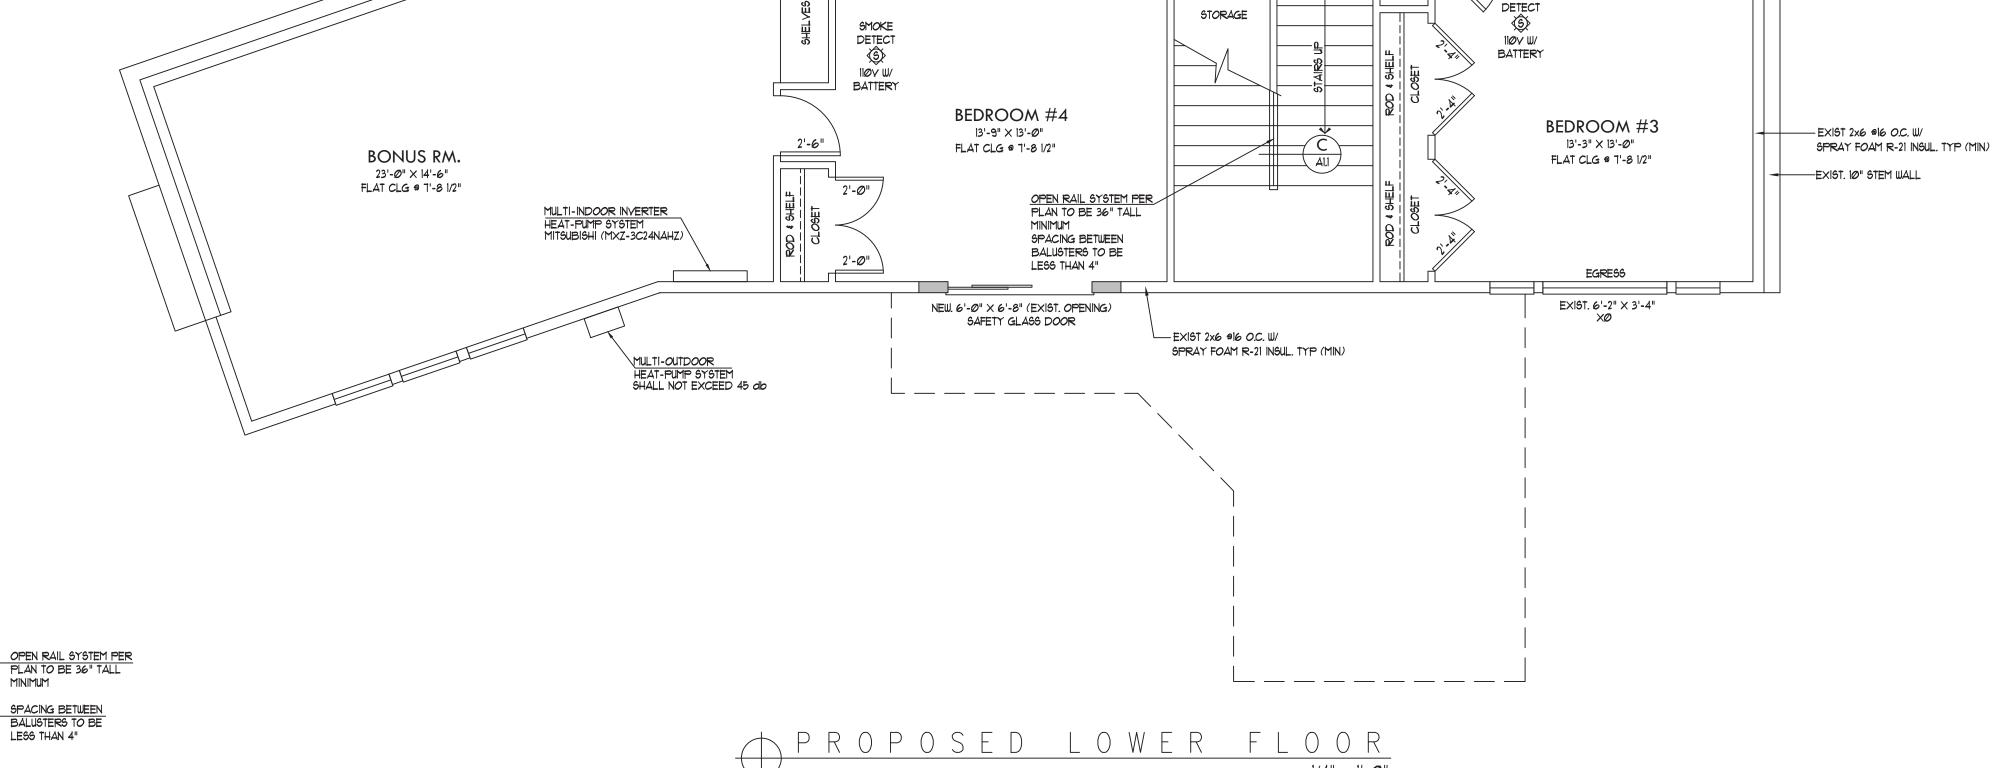

O EXISTING MAIN FLOOR=

O EXISTING LOWER FLOOR=

O EXISTING REAR (EAST) DECK=

O NEW MAIN FLOOR ADDITION=

O NEW ATTACHED GARAGE =

O EXISTING CAR-PORT (TO BE REMOVED)=

O EXISTING (SOUTH) PATIO (TO REMAIN)=

-EXISTING REAR DECK REMOVED =

2,628 SQ. FT.

1,338 SQ. FT.

386 SQ. FT.

316 SQ. FT.

-52 SQ. FT.

218 SQ. FT.

135 SQ. FT.

562 SQ. FT.

O TOTAL = 3,966 SQ. FT.

O TOTAL = 135 SQ. FT.

### <u>WTR HTR NOTES:</u>

TABLE M 1 5 0 7 . 3 . 3 (1) FAN EFFICACY

CONTINUOUS WHOLE—HOUSE MECHANICAL VENTILATION SYSTEM AIRFLOW RATE REQUIREMENTS

V.T.O.S.

DETECT

110V W/

BATTERY

W/ CARBON MONOXIDE

SMOKE

12:

LINEN

FLOOR AREA (square feet)

LESS THAN 1,500

1501 - 3,000

3*0*01 - 4500

4501 - 6*0*00

6,001 - 7,500

MORE THAN 1,500

V.T.O.S.

0-1 2-3 4-5 6-7

120

TANKLESS W/H
/ W/ EFFICIENCY

LAUNDRY

8'-Ø" × 12'-8"

FLAT CLG @ 7'-8 1/2|"

MOISTURE

V.T.O.S.

NPE-180A EXHAUST GOES UP INTO THE FLOOR

FRAMING AND EXISTS THOUGH THE

RIGHT (SOUTH) EXTERIOR WALL

IN SEISMIC ZONES D2, WATER
HEATERS SHALL BE ANCHORED OR
STRAPPED TO RESIST HORIZONTAL
DISPLACEMENT DUE TO EARTHQUAKE
MOTION. STRAPPING SHALL BE AT
POINTS WITHIN THE UPPER THIRD AND
LOWER THIRD OF ITS VERTICAL
DIMENSION

APPLIANCES CAPABLE OF PRODUCING A SPARK OR FLAME LOCATED IN A GARAGE SHALL BE INSTALLED WITH THE PILOT AND BURNERS OR HEATING ELEMENTS AT LEAST IS" ABOVE THE FLOOR SURFACE

NATURAL GAS FIRED FURNACE AND WTR HTR TO VENT TO OUTSIDE

WTR HTR TO HAVE PRESSURE RELIEF VALVE TO DRAIN BY GRAVITY TO OUTSIDE

IN ADDITION TO REQUIRED PRESSURE RELIEF VALVE, AN APPROVED AND LISTED EXPANSION TANK SHALL BE INSTALLED PER THE MANUF. SPECIFICATIONS

### SMOKE DETECTOR NOTE:

ALL SMOKE DETECTORS SHOWN ON THE PLAN WITH SYMBOL AT RIGHT TO BE INSTALLED PER 2015 IRC SECTION R314 REFER TO FULL CODE FOR ALL REQUIREMENTS

SMOKE DETECT
DETECT

SMOKE
DETECT

SMOKE
DETECT

SMOKE
DETECT

DETECT

SMOKE
DETECT

BATTERY

ALL DETECTORS TO BE LABELED IN ACCORDANCE WITH UL 217

ALL DETECTORS SHALL RECEIVE THEIR PRIMARY POWER FROM THE BUILDING WIRING AND BE EQUIPT WITH BATTERY BACKUP WHEN THE PRIMARY POWER IS INTERRUPTED

WHERE MULTIPLE DETECTORS ARE SHOWN ON THE PLAN, THE DEVICES SHALL BE INTERCONNECTED IN SUCH A MANNER THAT THE ACTIVATION OF ONE ALARM WILL ACTIVATE ALL OF THE ALARMS IN THE ENTIRE SFR STRUCTURE

#### R314.3 LOCATION

- SMOKE ALARMS SHALL BE INSTALLED IN THE FOLLOWING LOCATIONS:

  1. IN EACH SLEEPING ROOM.
- IN EACH SLEEPING ROOM.
   OUTSIDE EACH SEPERATE SLEEPING AREA IN THE IMMEDIATE VICINITY OF THE BEDROOMS.
- 3. ON EACH ADDITIONAL STORY OF THE DWELLING, INCLUDING BASEMENTS AND HABITABLE ATTICS BUT NOT INCLUDING CRAWL SPACE AND UNINHABITABLE ATTICS. IN DWELLINGS OR DWELLING UNITS WITH SPLIT LEVELS AND WITHOUT AN INTERVENING DOOR BETWEEN THE ADJACENT LEVELS, A SMOKE ALARM INSTALLED ON THE UPPER LEVEL SHALL SUFFICE FOR THE ADJACENT LOWER LEVEL IS LESS TUAN ONE BUIL STORY BELOWINGSPER LEVEL
- LEVEL IS LESS THAN ONE FULL STORY BELOW UPPER LEVEL.

  4. SMOKE ALARMS SHALL BE INSTALLED NOT LESS THAN 3 FEET HORIZONTALLY FROM THE DOOR OR OPENING OF A BATHROOM CONTAINS A BATHTUB OR SHOWER UNLESS THIS WOULD PROVENT PLACEMENT OF A SMOKE ALARM REQUIRED BY SECTION R314.3

# R314.3.1 ALTERATIONS, REPAIRS, & ADDITION

5. IN NAPPING AREAS IN A FAMILY HOME CHILD CARE.

WHEN ALTERATIONS, REPAIRS OR ADDITIONS REQUIRING A PERMIT OCCUR, OR WHEN ONE OR MORE SLEEPING ROOMS ARE ADDED OR CREATED IN EXISTING DWELLINGS, THE INDIVIDUAL DWELLING UNIT SHALL BE EQUIPPED WITH SMOKE ALARMS AS REQUIRED FOR NEW DWELLINGS.

CARBON MONOXIDE ALARMS

ALL CARBON MONOXIDE DETECTORS
SHOWN ON THE PLAN WITH SYMBOL
TO THE RIGHT SHALL BE INSTALLED
PER 2015 IRC SECTION R315 REFER TO FULL
CODE FOR ALL REQUIREMENTS

ALL DETECTORS TO BE LABELED IN ACCORDANCE WITH UL 2034 FOR SINGLE STATION ALARMS

# R315.2.2 ALTERNATIONS, REPAIRS, AND ADDITIONS

EXISTING DWELLING SHALL BE EQUIPPED WITH CARBON MONOXIDE ALARMS IN ACCORDANCE WITH SECTION R315.2.1. AN INSPECTION WILL OCCUR WHEN ALTERATIONS, REPAIRS OR ADDITIONS REQUIRING A PERMIT OCCUR, OR WHEN ONE OR MORE SLEEPING ROOMS ARE ADDED OR CREATED.

### R315.3 LOCATION

CARBON MONOXIDE ALARMS IN DWELLING UNITS SHALL BE INSTALLED ON EACH LEVEL OF THE DWELLING UNIT AND OUTSIDE OF EACH SEPARATE SLEEPING. AREA IN THE IMMEDIATE VICINITY OF THE BEDROOMS. WHERE A FUEL-BURNING. APPLIANCE IS LOCATED WITHIN A BEDROOM OR ITS ATTACHED BATHROOM, A CARBON MONOXIDE ALARM SHALL BE INSTALLED WITHIN THE



CUSTOM HOMES
REMODELS
ADDITIONS

PAVEL2TRAVEL@GMAIL.COM

253.282.2277

S C A L E:

1/4" = 1'-0" ENGINEERING:

BLDG DEPT: MERCER ISLAND

CHECKED BY:

PRINT DATE: 12.9.20

REVISIONS

12.9.20 PRELIMINARY PVS

BUILDER APPROVAL:

DA

OWNER APPROVAL:

DATE

PLAN NUMBER

2038 PROJECT

PREMIUM HOMES
OF MERCER ISL
REMODEL

2906 74th Ave SE Mercer Island W A S H I N G T O N 9 8 0 4 0

531510-0836

SHEET TITLE: PROPOSED MAIN FLOOR PLAN

SHEET NUMBER:

1 1 1

0 2' 4' 6' 8' 3 C A | F | 1/4 " = 1' - 0 "

C HAND RAIL DETAIL

HANDRAIL TO BE CONTINUOUS

AT ALL STAIRS W/ MORE THAN

4" RISERS RAIL TO RETURN

TO WALL AT EACH END


RAIL CROSS SECTION TO

BE BETWEEN 14" AND 2"


BETWEEN 34" AND 38"

ABOVE STAIR NOSING

HANDRAIL TO BE MOUNTED

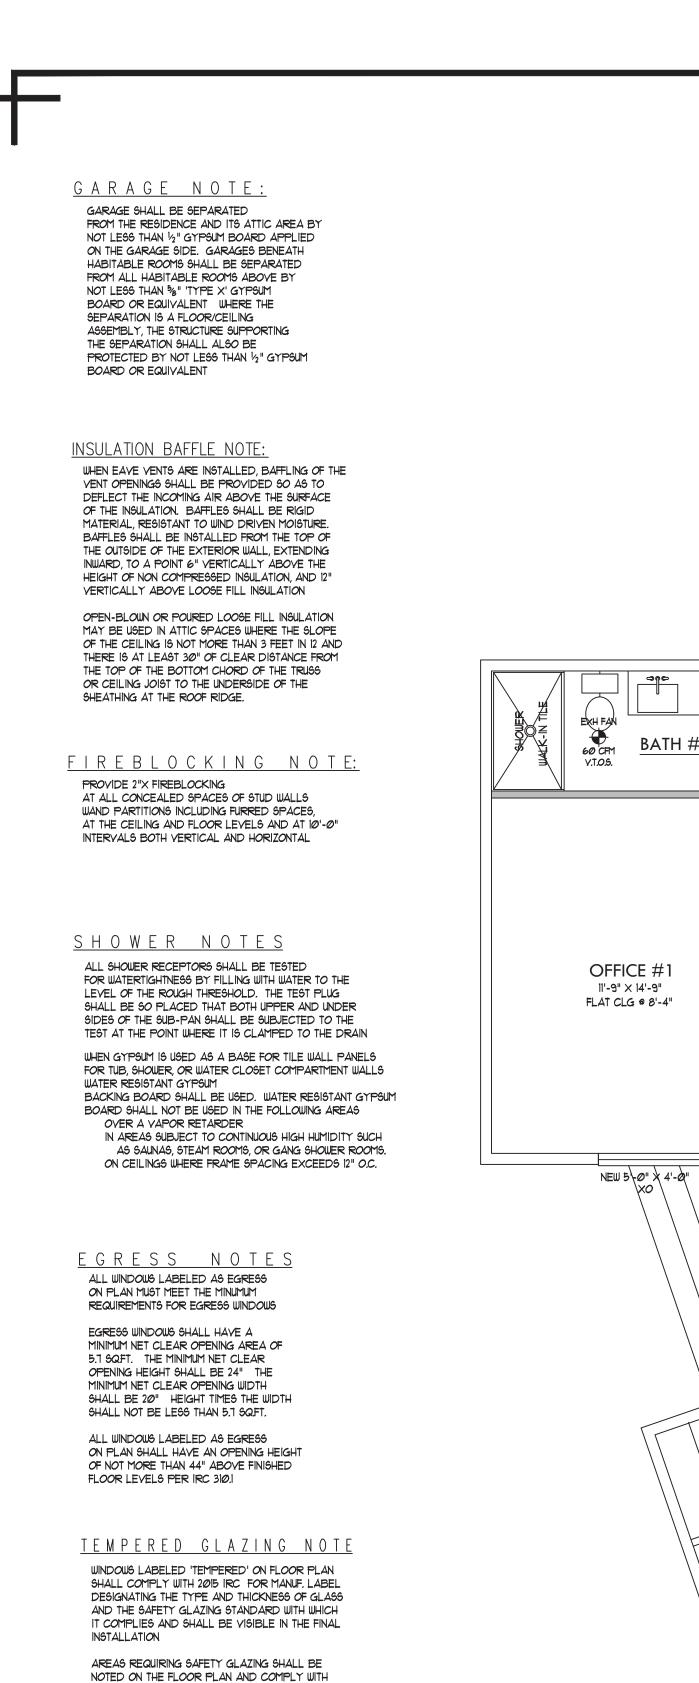

2015 IRC RATINGS STATED ABOVE

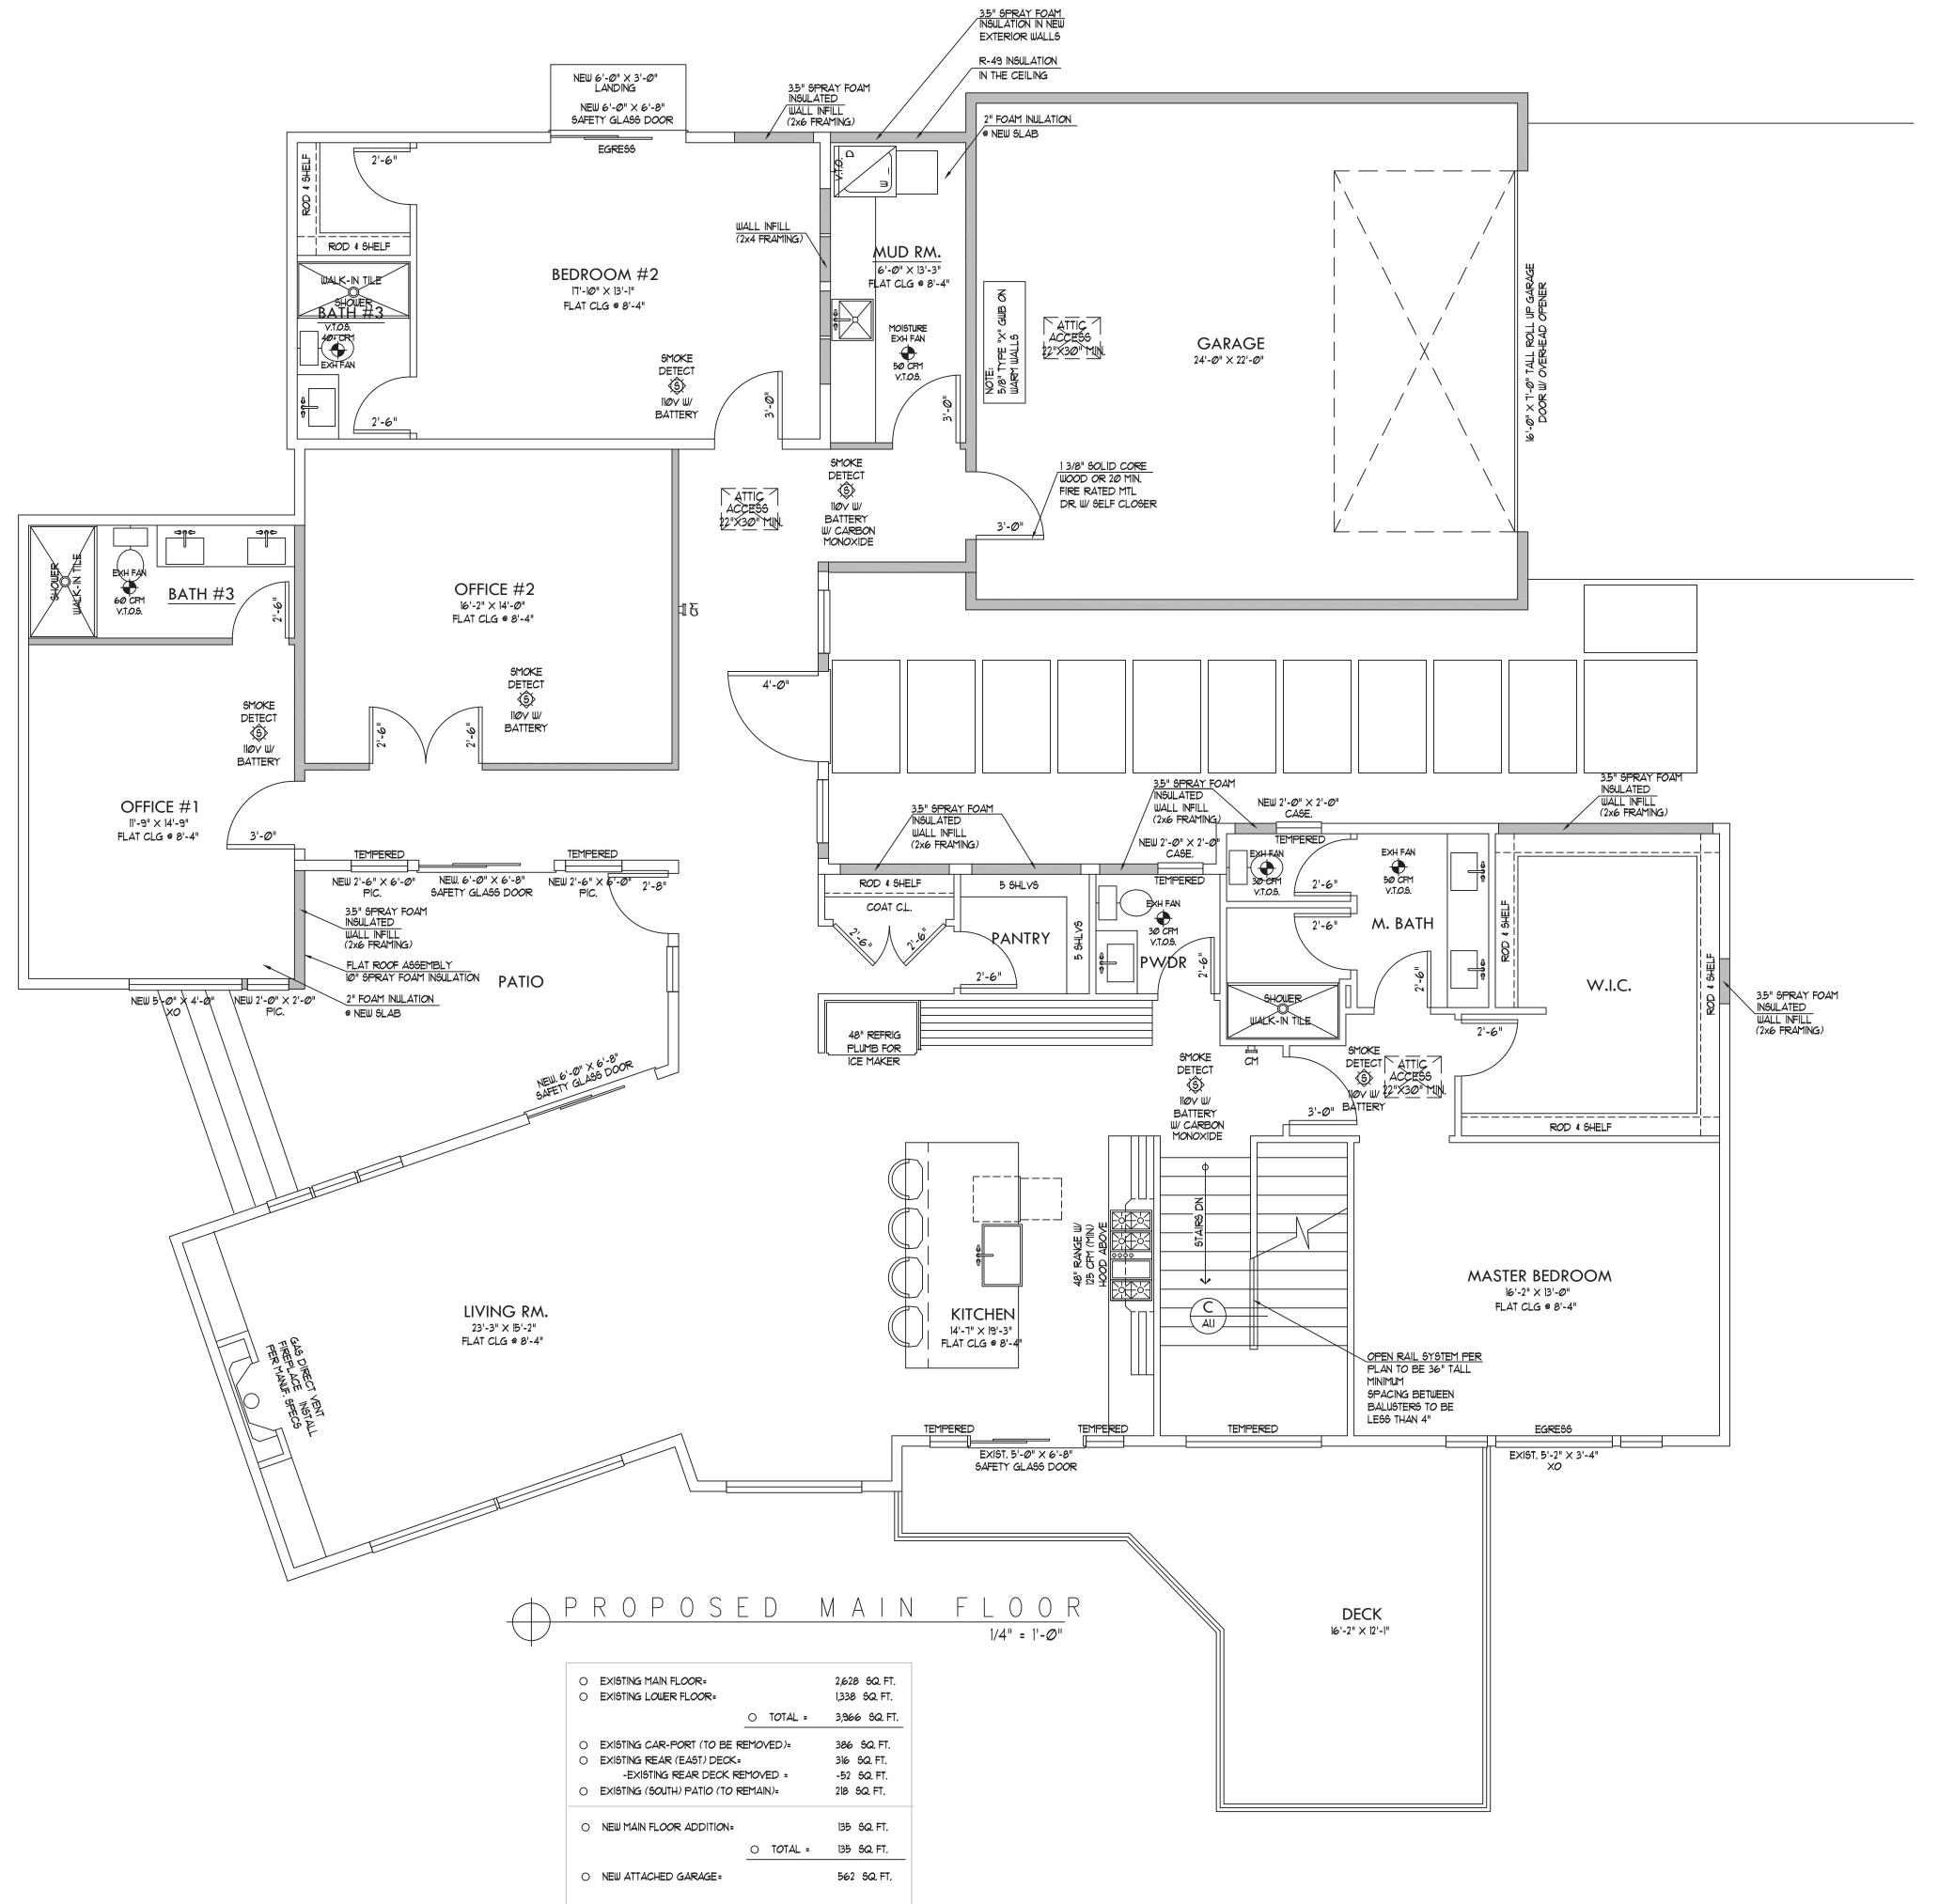

WTR HTR NOTES:

IN SEISMIC ZONES D2, WATER
HEATERS SHALL BE ANCHORED OR
STRAPPED TO RESIST HORIZONTAL
DISPLACEMENT DUE TO EARTHQUAKE
MOTION. STRAPPING SHALL BE AT
POINTS WITHIN THE UPPER THIRD AND
LOWER THIRD OF ITS VERTICAL
DIMENSION

APPLIANCES CAPABLE OF PRODUCING A SPARK OR FLAME LOCATED IN A GARAGE SHALL BE INSTALLED WITH THE PILOT AND BURNERS OR HEATING ELEMENTS AT LEAST 18" ABOVE THE FLOOR SURFACE

NATURAL GAS FIRED FURNACE AND WTR HTR TO VENT TO OUTSIDE

WTR HTR TO HAVE PRESSURE RELIEF VALVE TO DRAIN BY GRAVITY TO OUTSIDE

IN ADDITION TO REQUIRED PRESSURE RELIEF VALVE, AN APPROVED AND LISTED EXPANSION TANK SHALL BE INSTALLED PER THE MANUF. SPECIFICATIONS

## SMOKE DETECTOR NOTE:

ALL SMOKE DETECTORS SHOWN ON THE PLAN WITH SYMBOL AT RIGHT TO BE INSTALLED PER 2015 IRC SECTION R314 REFER TO FULL CODE FOR ALL REQUIREMENTS

SMOKE DETECT

SMOKE DETECTORS

PAICE OF THE PROPER OF THE PROPERTY OF THE PROPER

ALL DETECTORS TO BE LABELED IN ACCORDANCE WITH UL 217

ALL DETECTORS SHALL RECEIVE THEIR PRIMARY POWER FROM THE BUILDING WIRING AND BE EQUIPT WITH BATTERY BACKUP WHEN THE PRIMARY POWER IS INTERRUPTED

WHERE MULTIPLE DETECTORS ARE SHOWN ON THE PLAN, THE DEVICES SHALL BE INTERCONNECTED IN SUCH A MANNER THAT THE ACTIVATION OF ONE ALARM WILL ACTIVATE ALL OF THE ALARMS IN THE ENTIRE SFR STRUCTURE

#### R314.3 LOCATION

- SMOKE ALARMS SHALL BE INSTALLED IN THE FOLLOWING LOCATIONS:

  1. IN EACH SLEEPING ROOM.
- IN EACH SLEEPING ROOM.
   OUTSIDE EACH SEPERATE SLEEPING AREA IN THE IMMEDIATE VICINITY OF THE BEDROOMS.
- 3. ON EACH ADDITIONAL STORY OF THE DWELLING, INCLUDING BASEMENTS AND HABITABLE ATTICS BUT NOT INCLUDING CRAWL SPACE AND UNINHABITABLE ATTICS. IN DWELLINGS OR DWELLING UNITS WITH SPLIT LEVELS AND WITHOUT AN INTERVENING DOOR BETWEEN THE ADJACENT LEVELS, A SMOKE ALARM INSTALLED ON THE UPPER LEVEL SHALL SUFFICE FOR THE ADJACENT LOWER LEVEL IS LESS THAN ONE FULL STORY BELOW UPPER LEVEL.
- 4. SMOKE ALARMS SHALL BE INSTALLED NOT LESS THAN 3 FEET HORIZONTALLY FROM THE DOOR OR OPENING OF A BATHROOM CONTAINS A BATHTUB OR SHOWER UNLESS THIS WOULD PROVENT PLACEMENT OF A SMOKE ALARM REQUIRED BY SECTION R314.3
- 5. IN NAPPING AREAS IN A FAMILY HOME CHILD CARE.

# R314.3.1 ALTERATIONS, REPAIRS, & ADDITION

WHEN ALTERATIONS, REPAIRS OR ADDITIONS REQUIRING:
A PERMIT OCCUR, OR WHEN ONE OR MORE SLEEPING ROOMS
ARE ADDED OR CREATED IN EXISTING DWELLINGS, THE
INDIVIDUAL DWELLING UNIT SHALL BE EQUIPPED WITH
SMOKE ALARMS AS REQUIRED FOR NEW DWELLINGS.

CARBON MONOXIDE ALARMS

ALL CARBON MONOXIDE DETECTORS
SHOWN ON THE PLAN WITH SYMBOL
TO THE RIGHT SHALL BE INSTALLED
PER 2015 IRC SECTION R315 REFER TO FULL
CODE FOR ALL REQUIREMENTS

ALL DETECTORS TO BE LABELED IN ACCORDANCE WITH UL 2034 FOR SINGLE STATION ALARMS

# R315.2.2 ALTERNATIONS, REPAIRS, AND ADDITIONS

EXISTING DWELLING SHALL BE EQUIPPED WITH CARBON MONOXIDE ALARMS IN ACCORDANCE WITH SECTION R315.2.1. AN INSPECTION WILL OCCUR WHEN ALTERATIONS, REPAIRS OR ADDITIONS REQUIRING A PERMIT OCCUR, OR WHEN ONE OR MORE SLEEPING ROOMS ARE ADDED OR CREATED.

### R315.3 LOCATION

CARBON MONOXIDE ALARMS IN DWELLING UNITS SHALL BE INSTALLED ON EACH LEVEL OF THE DWELLING UNIT AND OUTSIDE OF EACH SEPARATE SLEEPING AREA IN THE IMMEDIATE VICINITY OF THE BEDROOMS. WHERE A FUEL-BURNING APPLIANCE IS LOCATED WITHIN A BEDROOM OR ITS ATTACHED BATHROOM, A CARBON MONOXIDE ALARM SHALL BE INSTALLED WITHIN THE BEDROOM.



CUSTOM HOMES
REMODELS
ADDITIONS

PAVEL2TRAVEL@GMAIL.COM

253.282.2277

\_\_\_

1/4" = 1'-0" ENGINEERING:

SCALE:

BLDG DEPT: MERCER ISLAND

CHECKED BY:

PRINT DATE: 12.9.20

REVISIONS

12.9.20 PRELIMINARY PVS

BUILDER APPROVAL:

DATE

OWNER APPROVAL:

DATE

- -

PROJECT

PLAN NUMBER

PREMIUM HOMES
OF MERCER ISL
REMODEL


2906 74th Ave SE Mercer Island W A S H I N G T O N 9 8 0 4 0

5 3 1 5 1 0 - 0 8 3 6

SHEET TITLE: PROPOSED LOWER FLOOR PLAN

SHEET NUMBER:

A — 1 7

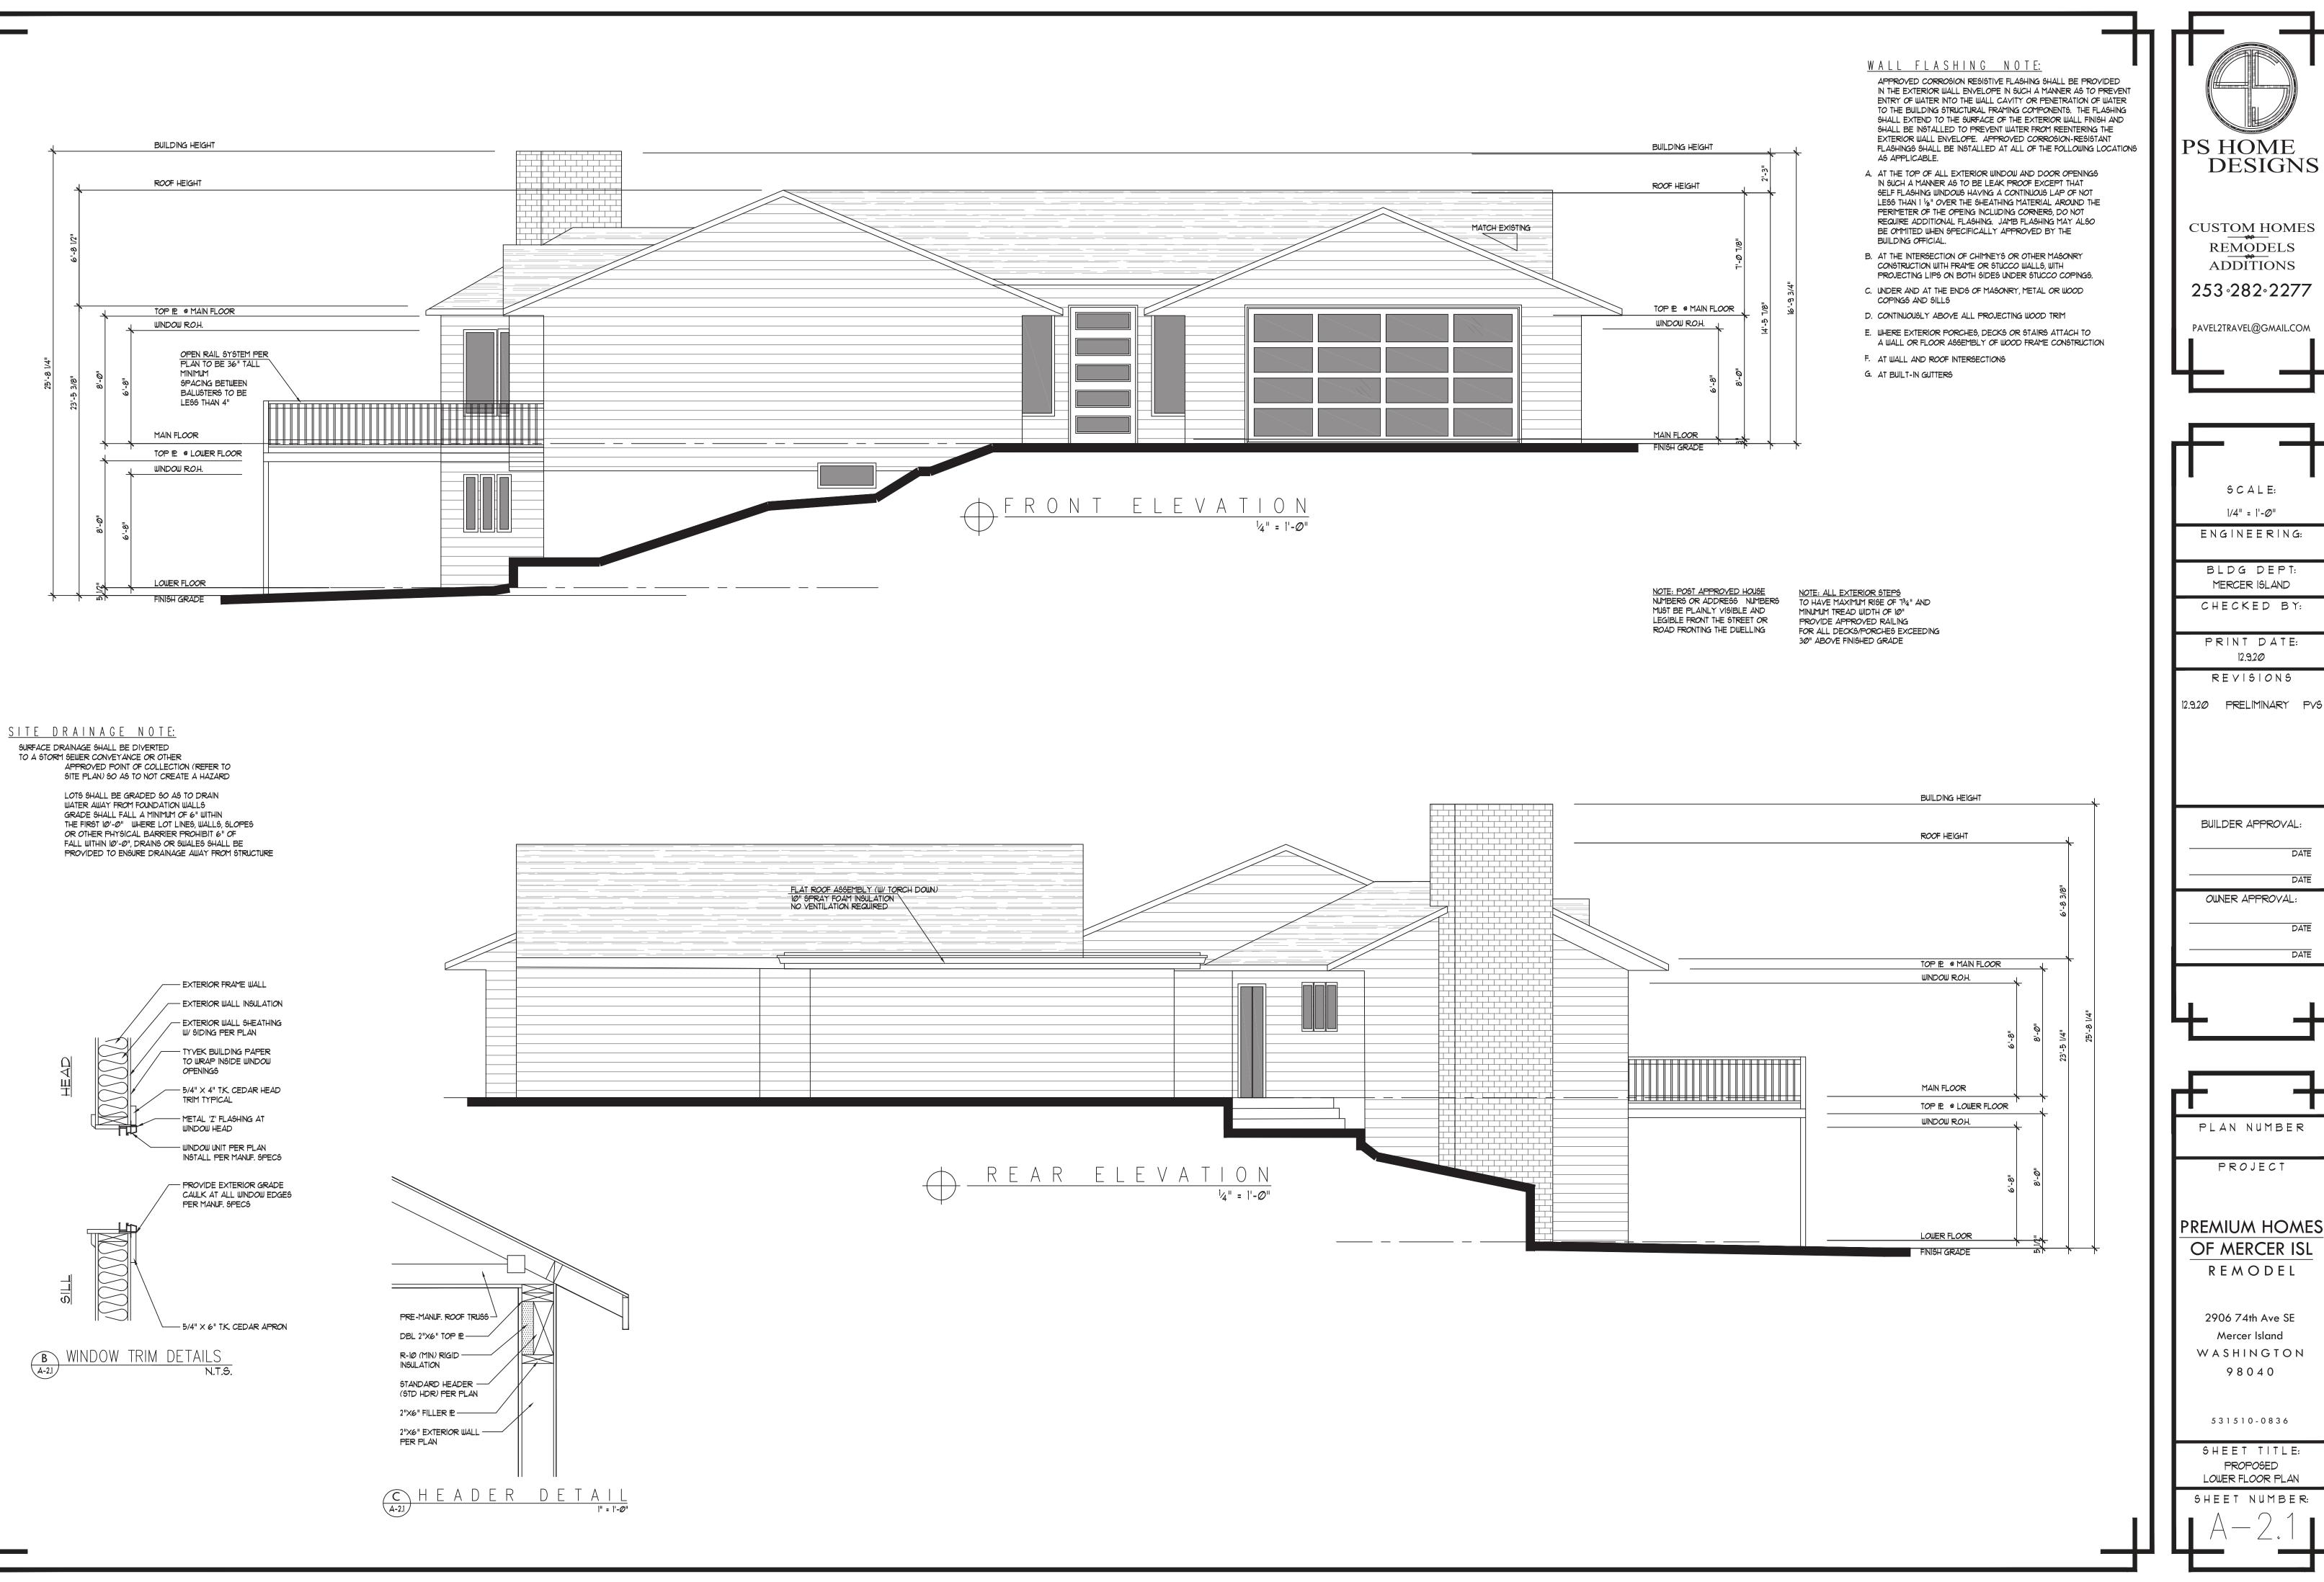



PS HOME **DESIGNS** 

CUSTOM HOMES REMODELS **ADDITIONS** 253.282.2277

PAVEL2TRAVEL@GMAIL.COM

SCALE:

1/4" = 1'-Ø"

ENGINEERING: BLDG DEPT: MERCER ISLAND CHECKED BY: PRINT DATE: 12.9.20 REVISIONS 12.9.20 PRELIMINARY PVS BUILDER APPROVAL: DATE OWNER APPROVAL:

PLAN NUMBER PROJECT

OF MERCER ISL REMODEL

2906 74th Ave SE Mercer Island WASHINGTON 98040

531510-0836

SHEET TITLE: PROPOSED LOWER FLOOR PLAN

SHEET NUMBER:

NOTE: POST APPROVED HOUSE NUMBERS OR ADDRESS NUMBERS MUST BE PLAINLY VISIBLE AND LEGIBLE FRONT THE STREET OR ROAD FRONTING THE DWELLING

FLAT ROOF ASSEMBLY (W/ TORCH DOWN)

10" SPRAY FOAM INSULATION

NO VENTILATION REQUIRED

TOP PE @ MAIN FLOOR

WINDOW R.O.H.

FINISH GRADE

NOTE: ALL EXTERIOR STEPS TO HAVE MAXIMUM RISE OF 134" AND MINUMUM TREAD WIDTH OF 10" PROVIDE APPROVED RAILING FOR ALL DECKS/PORCHES EXCEEDING 30" ABOVE FINISHED GRADE

<u>SITE DRAINAGE NOTE:</u>

SURFACE DRAINAGE SHALL BE DIVERTED TO A STORM SEWER CONVEYANCE OR OTHER APPROVED POINT OF COLLECTION (REFER TO SITE PLAN) SO AS TO NOT CREATE A HAZARD

LOTS SHALL BE GRADED SO AS TO DRAIN WATER AWAY FROM FOUNDATION WALLS GRADE SHALL FALL A MINIMUM OF 6" WITHIN THE FIRST 10'-0" WHERE LOT LINES, WALLS, SLOPES OR OTHER PHYSICAL BARRIER PROHIBIT 6" OF FALL WITHIN 10'-0", DRAINS OR SWALES SHALL BE PROVIDED TO ENSURE DRAINAGE AWAY FROM STRUCTURE

BUILDING HEIGHT

TOP E @ MAIN FLOOR

WINDOW R.O.H.

MAIN FLOOR

WINDOW R.O.H.

FINISH GRADE

TOP IE @ LOWER FLOOR


ROOF HEIGHT

WALL FLASHING NOTE:

APPROVED CORROSION RESISTIVE FLASHING SHALL BE PROVIDED IN THE EXTERIOR WALL ENVELOPE IN SUCH A MANNER AS TO PREVENT ENTRY OF WATER INTO THE WALL CAVITY OR PENETRATION OF WATER TO THE BUILDING STRUCTURAL FRAMING COMPONENTS. THE FLASHING SHALL EXTEND TO THE SURFACE OF THE EXTERIOR WALL FINISH AND SHALL BE INSTALLED TO PREVENT WATER FROM REENTERING THE EXTERIOR WALL ENVELOPE. APPROVED CORROSION-RESISTANT FLASHINGS SHALL BE INSTALLED AT ALL OF THE FOLLOWING LOCATIONS AS APPLICABLE.

- A. AT THE TOP OF ALL EXTERIOR WINDOW AND DOOR OPENINGS IN SUCH A MANNER AS TO BE LEAK PROOF EXCEPT THAT SELF FLASHING WINDOWS HAVING A CONTINUOUS LAP OF NOT LESS THAN I 1/2" OVER THE SHEATHING MATERIAL AROUND THE PERIMETER OF THE OPEING INCLUDING CORNERS, DO NOT REQUIRE ADDITIONAL FLASHING. JAMB FLASHING MAY ALSO BE OMMITED WHEN SPECIFICALLY APPROVED BY THE BUILDING OFFICIAL.
- B. AT THE INTERSECTION OF CHIMNEYS OR OTHER MASONRY CONSTRUCTION WITH FRAME OR STUCCO WALLS, WITH PROJECTING LIPS ON BOTH SIDES UNDER STUCCO COPINGS.
- C. UNDER AND AT THE ENDS OF MASONRY, METAL OR WOOD COPINGS AND SILLS
- D. CONTINUOUSLY ABOVE ALL PROJECTING WOOD TRIM
- E. WHERE EXTERIOR PORCHES, DECKS OR STAIRS ATTACH TO
- A WALL OR FLOOR ASSEMBLY OF WOOD FRAME CONSTRUCTION F. AT WALL AND ROOF INTERSECTIONS

G. AT BUILT-IN GUTTERS

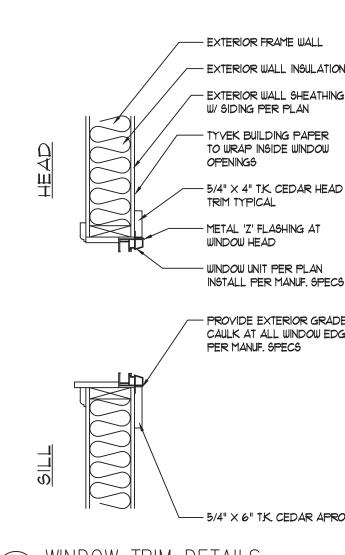

EXTERIOR WALL INSULATION - EXTERIOR WALL SHEATHING - 5/4" imes 4" T.K. CEDAR HEAD INSTALL PER MANUF, SPECS PROVIDE EXTERIOR GRADE CAULK AT ALL WINDOW EDGES 5/4" × 6" T.K. CEDAR APRON

### <u>SITE DRAINAGE NOTE:</u>

PRE-MANUF. ROOF TRUSS-

STANDARD HEADER -(STD HDR) PER PLAN

2"X6" EXTERIOR WALL -


2"X6" FILLER #2 —


PER PLAN

DBL 2"X6" TOP 12-R-10 (MIN) RIGID -INSULATION

SURFACE DRAINAGE SHALL BE DIVERTED TO A STORM SEWER CONVEYANCE OR OTHER APPROVED POINT OF COLLECTION (REFER TO SITE PLAN) SO AS TO NOT CREATE A HAZARD

LOTS SHALL BE GRADED SO AS TO DRAIN WATER AWAY FROM FOUNDATION WALLS GRADE SHALL FALL A MINIMUM OF 6" WITHIN THE FIRST 10'-0" WHERE LOT LINES, WALLS, SLOPES OR OTHER PHYSICAL BARRIER PROHIBIT 6" OF FALL WITHIN 10'-0", DRAINS OR SWALES SHALL BE PROVIDED TO ENSURE DRAINAGE AWAY FROM STRUCTURE

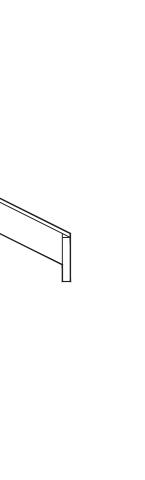

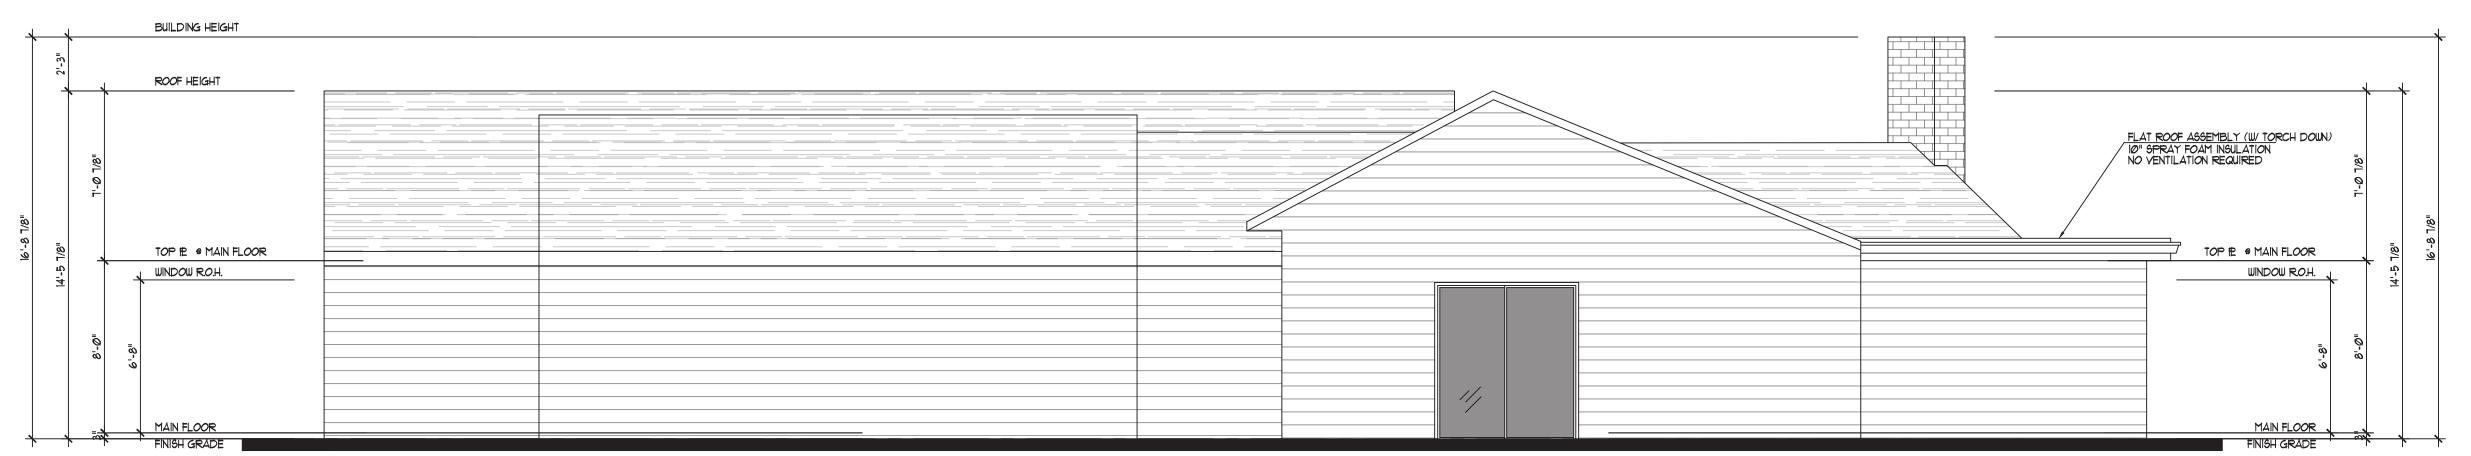

PROJECT PREMIUM HOMES

PLAN NUMBER

PS HOME

**DESIGNS** 

CUSTOM HOMES

REMODELS

**ADDITIONS** 

253.282.2277

PAVEL2TRAVEL@GMAIL.COM

SCALE:

1/4" = 1'-Ø"

ENGINEERING:

BLDG DEPT:

MERCER ISLAND

CHECKED BY:

PRINT DATE: 12.9.20

REVISIONS

12.9.20 PRELIMINARY PVS

BUILDER APPROVAL:

OWNER APPROVAL:

DATE

OF MERCER ISL REMODEL

2906 74th Ave SE Mercer Island WASHINGTON 98040

531510-0836

SHEET TITLE: PROPOSED LOWER FLOOR PLAN

SHEET NUMBER: